

SLOPE AREA TABLE (ENTIRE LOT AREA)					
NO.	SLOPE CLASS MIN.	SLOPE CLASS MAX.	AREA (s.f.)	% OF LOT AREA	COLOR
1	0.00%	15.00%	45,614	42.8%	Light Gray
2	15.00%	20.00%	20,443	19.2%	Medium Gray
3	20.00%	30.00%	26,878	25.2%	Yellow
4	30.00%	MAX.	13,656	12.8%	Dark Yellow

SLOPE RANGE - DISTURBED AREA ONLY				
NO.	SLOPE CLASS MIN.	SLOPE CLASS MAX.	AREA (s.f.)	COLOR
1	0.00%	15.00%	42,858	Light Gray
2	15.00%	20.00%	20,443	Medium Gray
3	20.00%	30.00%	24,565	Yellow
4	30.00%	MAX.	6,781	Dark Yellow

WETLAND CHART			
HATCH	CATEGORY	AREA	DISTURBANCE AREA
	WETLANDS	1,677 SF	1,389 SF
	WETLAND BUFFER	27,924 SF	24,231 SF

Table of Soil Characteristics					
Ref:	NRCS Web Soil Survey, National Cooperative Soil Survey				
Map Unit Symbol	Map Unit Name & Description	Hydro Group	Depth to Bedrock	Depth to Water	Drainage Class
PnC	Paxton fine sandy loam, 8 to 15 percent slopes	C	20" TO 39"	18" to 37"	Well Drained
LcB	Leicester loam, 2 to 8 percent slopes, very stony	A/D	> 80"	6" TO 18"	Somewhat Poorly Drained



NO.	REVISION	DATE
1	ISSUED TO PLANNING BOARD	7/19/2023

CONSTRAINTS LEGEND

- PROPERTY LINE
- LIMITS OF DISTURBANCE
- EXISTING CONTOUR LINE
- 100 FT. WETLAND SETBACK
- LOCAL FLAGGED WETLAND LINE
- EXISTING TREE W/ SIZE & SPECIES

SCALE IN FEET

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Under New York State Education Law Article 145 (Engineering), Section 7209 (2), It Is A Violation Of This Law For Any Person, Unless Acting Under The Direction Of A Licensed Professional Engineer, To Alter This Document

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Certificate Of Authorization #0017846

CORTLANDT MANOR HOTEL
2054 EAST MAIN STREET
TOWN OF CORTLANDT, NY
Section 23.20, Block: 1, Lots: 2 & 3

TITLE:
EXISTING CONDITIONS AND CONSTRAINTS PLAN

Scale: 1" = 30'

Date: 04/26/2023


Drawn By: KMM

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Project No.: 1021

Sheet No.: 2 of 12

Dwg. No.: C-101

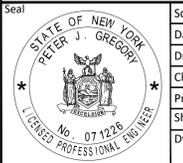


G:\PROJECTS\DTS\1021 - Cortlandt Manor\AutoCAD\SPAC-101 Constraints Map.dwg

SIGN LEGEND			
PLAN LEGEND	MUTCD	SIZE	SIGN LEGEND
1	R7-8X	12" x 18"	RESERVED PARKING (SYMBOL)
2	R7-8P	12" x 9"	VAN ACCESSIBLE
3	R1-1	12" x 18"	STOP
4	R7-1	12" x 18"	NO PARKING ANY TIME <->
5	NA	12" x 18"	ELECTRIC VEHICLE CHARGING

NOTES:

- ALL SIGNS SHALL CONFORM TO THE NATIONAL MANUAL ON UNIFORM TRAFFIC CONTROL DEVICES FOR STREETS AND HIGHWAYS AND THE NEW YORK STATE SUPPLEMENT, LATEST REVISION.
- A MINIMUM OF TWO CROSS BRACES SHALL BE PROVIDED ON ALL SINGLE CHANNEL SIGNS HAVING ANY DIMENSION GREATER THAN 24 INCHES.
- ALL SIGNS SHALL HAVE A MOUNTING HEIGHT OF 7'-0" TO THE BOTTOM OF THE SIGN.
- ALL SIGNS SHALL UTILIZE A CHANNEL-TYPE MOUNTING.
- ALL SIGNS SHALL BE REFLECTORIZED.
- SIGNS NO. 6 & 7 SHALL HAVE A RED LEGEND WITH WHITE BACKGROUND.

TOWN OF CORTLANDT SCHEDULE OF PARKING REQUIREMENTS AS PER SECTION 301-29	
USE:	MINIMUM NUMBER OF SPACES
HOTEL	1 PER ROOM PLUS 1 PER EMPLOYEE ON MAXIMUM SHIFT
NUMBER OF PROPOSED ROOMS = 93	
NUMBER OF EMPLOYEES ON MAXIMUM SHIFT = 7	
REQUIRED NUMBER OF SPACES	93 SPACES + 7 SPACES 100 SPACES REQUIRED
NUMBER OF PROPOSED PARKING SPACES:	93 SPACES WITH 4 ACCESSIBLE SPACES* *VARIANCE REQUIRED
TOTAL AREA OF PERIMETER OF PARKING AREA = 15,282 S.F.	
5% OF TOTAL OF PARKING AREA = 765 S.F.	
LANDSCAPE AREA PROVIDED AROUND PARKING AREA = 5,624 S.F.	

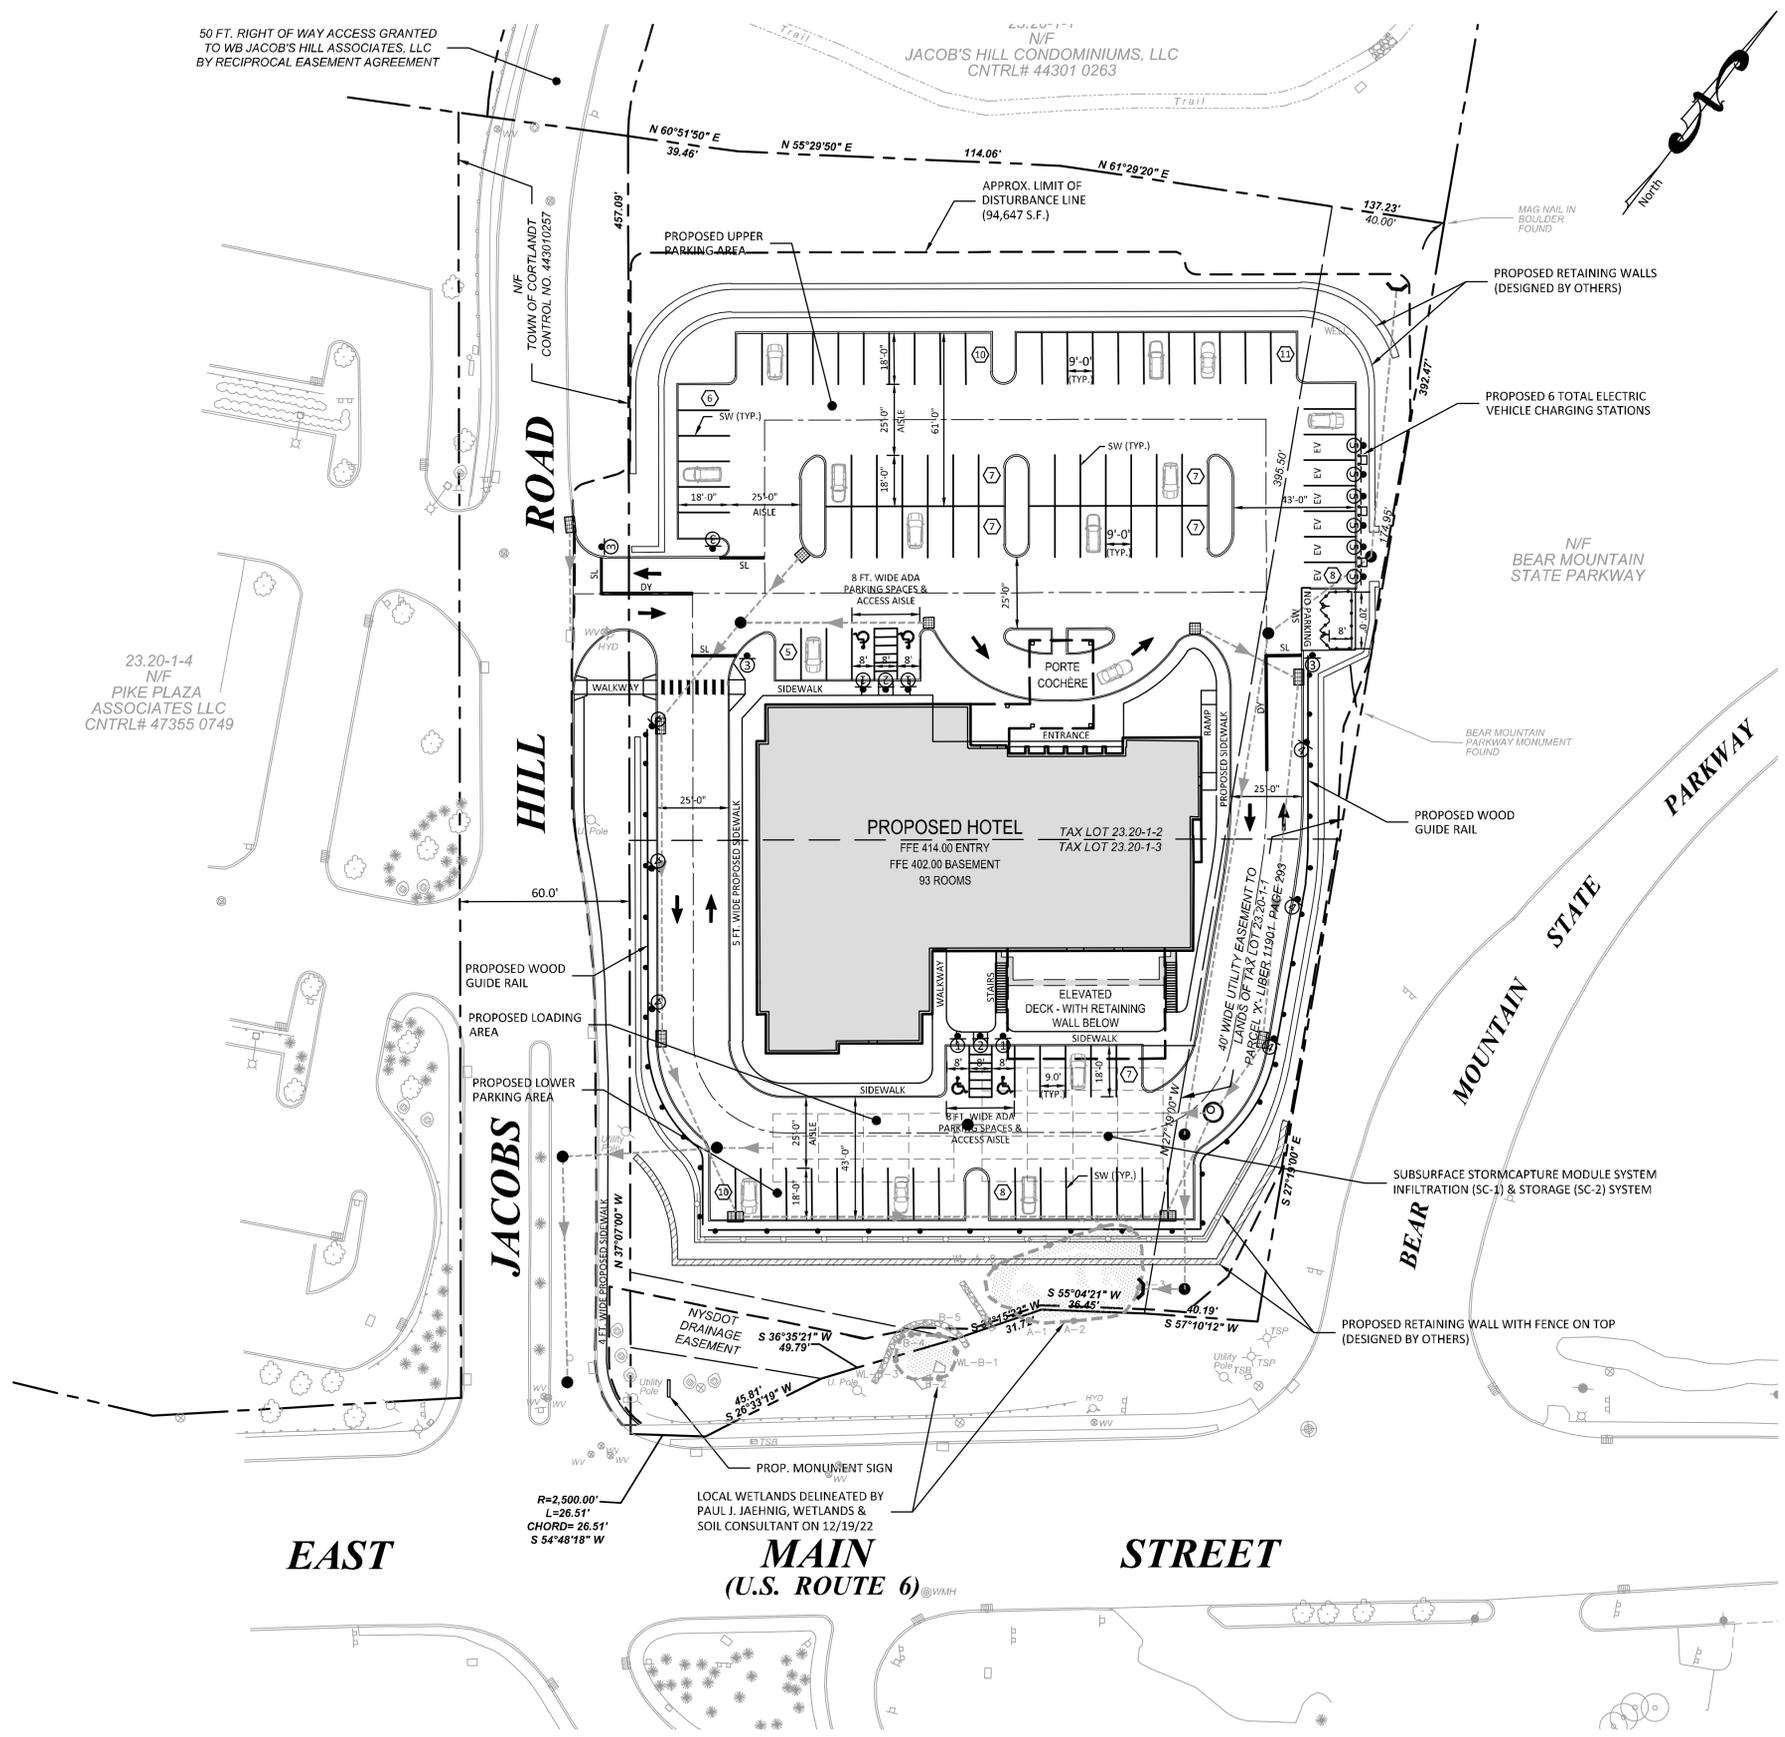

NO.	REVISION	DATE
1	PLANNING BOARD REVIEW	5/31/2023
2	ISSUED TO PLANNING BOARD	7/19/2023

STRIPING & SIGN PLAN LEGEND	
SW	SOLID WHITE LINE, 4" WIDE
SL	STOP LIMIT LINE, WHITE, 12" WIDE
DY	DOUBLE YELLOW, 2 LINES, 4" WIDE
(20)	NO. OF PARKING STALLS PER BAY LINE
(P)	PROPOSED TRAFFIC SIGN
(A)	ADA PAVEMENT MARKING (BLUE)
(A)	PAINTED DIRECTIONAL ARROW (WHITE)
EV	ELECTRIC VEHICLE CHARGING STATION (6 TOTAL)

SCALE IN FEET

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TOWN OF CORTLANDT, NY
Section 23.20, Block: 1, Lots: 2 & 3

TITLE:	
STRIPING & SIGN PLAN	
Scale:	1"=30'
Date:	04/26/2023
Drawn By:	KMM
Checked By:	PJG
Project No.:	1021
Sheet No.:	6 of 12
Dwg. No.:	C-301




NEW YORK SOIL EROSION AND SEDIMENT CONTROL NOTES

- SOIL EROSION AND SEDIMENT CONTROL (E&S) MEASURES/PRACTICES SHALL BE INSTALLED IN ACCORDANCE WITH NEW YORK STANDARDS AND SPECIFICATIONS FOR EROSION AND SEDIMENT CONTROL (BLUE BOOK), LATEST REVISION, AND PART I.B. OF THE NYSDC SPDES GENERAL PERMIT FOR STORMWATER DISCHARGES FROM CONSTRUCTION ACTIVITY, PERMIT NO. GP-0-20-001.
- THE OWNER/OPERATOR, CONSTRUCTION MANAGER, CONTRACTOR, AND/OR OTHER REPRESENTATIVE MUST NOTIFY THE DESIGNATED M54 OFFICIAL AT LEAST 48 HOURS IN ADVANCE OF THE COMMENCEMENT OF ANY LAND DISTURBANCE ACTIVITY, SO THAT INSPECTIONS CAN BE SCHEDULED.
- E&S MEASURES/PRACTICES, AS COORDINATED WITH THE PHASING/TIMING OF PROJECT CONSTRUCTION, SHALL BE INSTALLED/IMPLEMENTED IN ACCORDANCE WITH THE CONSTRUCTION SEQUENCE NOTES ON THE DRAWINGS AND/OR AS SPECIFIED IN THE SWPPP. E&S DEVICES/PRACTICES SHALL BE INSTALLED BY THE CONTRACTOR AFTER VEGETATIVE CLEARING OPERATIONS AND PRIOR TO ANY GRADING OR OTHER MAJOR SOIL DISTURBANCE.
- THE CONTRACTOR SHALL CONFINED SOIL DISTURBANCE ACTIVITIES TO THE AREAS CONTAINED WITHIN THE LIMITS OF CONSTRUCTION WORKSPACE/LIMITS OF PROJECT DISTURBANCE SHOWN ON THE PLANS. SUCH ACTIVITY SHALL GENERALLY CONSIST OF, BUT NOT BE LIMITED TO, CLEARING, GRUBBING, ROW AND TEMPORARY CONSTRUCTION WORKSPACE DEMOLITION, EARTHWORK AND GRADING, UTILITY TRENCH EXCAVATION, BACKFILLING, HYDROSTATIC TESTING, AND SITE RESTORATION AND STABILIZATION.
- THE TRAINED CONTRACTOR (AS DEFINED IN GP-0-20-001) SHALL INSPECT THE E&S DEVICES/PRACTICES AND POLLUTION PREVENTION MEASURES BEING IMPLEMENTED WITHIN ALL WORK AREAS (ACTIVE AND INACTIVE) DAILY UNTIL EITHER TEMPORARY OR PERMANENT STABILIZATION HAS BEEN ACHIEVED, TO ENSURE THAT THEY ARE BEING MAINTAINED IN AN EFFECTIVE OPERATING CONDITION AT ALL TIMES.
- THE CONTRACTOR SHALL REPAIR OR REPLACE DAMAGED E&S DEVICES/MEASURES WITHIN TWENTY-FOUR (24) HOURS AFTER OBSERVING SUCH DEFICIENCIES, OR AFTER SUCH DEFICIENCIES ARE REPORTED BY THE INSPECTOR(S), NYCDPE AND/OR DESIGNATED M54 OFFICIAL.
- THE CONTRACTOR SHALL BE PREPARED, IN ACCORDANCE WITH NOTE NO. 10 BELOW, TO IMPLEMENT ADDITIONAL AND/OR INTERIM DRAINAGE CONTROLS AND E&S MEASURES/PRACTICES AS MAY BE NECESSARY DURING THE COURSE OF CONSTRUCTION.
- THE CONTRACTOR SHALL MAKE AVAILABLE ON-SITE ALL EQUIPMENT, MATERIALS AND LABOR NECESSARY TO EFFECT EMERGENCY E&S AND DRAINAGE IMPROVEMENTS WITHIN TWENTY-FOUR (24) HOURS OF ANY IMPENDING EMERGENCY SITUATION.
- SOIL E&S MEASURES/PRACTICES SHALL BE MAINTAINED BY THE CONTRACTOR UNTIL FINAL ACCEPTANCE OF THE SITE WORK BY THE ENVIRONMENTAL INSPECTOR(S) AND/OR NYCDPE. UPON CERTIFICATION OF FINAL ACCEPTANCE, THE OWNER/OPERATOR SHALL ASSUME RESPONSIBILITY FOR THE CONTINUED MAINTENANCE OF PERMANENTLY RESTORED AREAS.
- THE ENVIRONMENTAL AND/OR E&S INSPECTOR(S), NYCDPE, AND/OR DESIGNATED M54 OFFICIAL MAY REQUEST THE INSTALLATION OF ADDITIONAL MEASURES TO MINIMIZE THE POTENTIAL FOR ON-SITE OR OFF-SITE EROSION AND/OR SEDIMENTATION OCCURRING DURING CONSTRUCTION.
- TEMPORARY SOIL STABILIZATION** - IN AREAS WHERE SOIL DISTURBANCE ACTIVITY HAS TEMPORARILY CEASED AND IS NOT SUBJECT TO CONSTRUCTION TRAFFIC, APPLICATION OF THE BELOW MEASURES MUST BE INITIATED BY THE END OF THE NEXT BUSINESS DAY AND COMPLETED WITHIN SEVEN (7) DAYS FROM THE DATE THE SOIL DISTURBANCE ACTIVITY CEASED. THE MEASURES SHALL BE DONE IN ACCORDANCE WITH THE BLUE BOOK, AS FOLLOWS:
 - FERTILIZER: FERTILIZER OR LIME WILL NOT BE USED.
 - SEED: ANNUAL RYE, WHICH SHALL INCLUDE EITHER ANNUAL RYEGRASS (LOLIUM PERENNE SSP. MULTIFLORUM) APPLIED AT THE RATE OF 30 LBS./ACRE, OR WINTER RYE.
 - MULCH: SMALL GRAIN STRAW MULCH APPLIED AT A RATE OF 90-100 LBS./1000 S.F. OR 2 TONS/ACRE, OR EQUIVALENT, TO BE APPLIED AND ANCHORED ACCORDING TO THE NYS STANDARDS OR AS SPECIFIED ON THE DRAWINGS.
 - PAVED AREAS: ARE CONSIDERED STABILIZED AFTER PLACEMENT AND COMPACTION OF PAVEMENT SUBBASE/BEDDING MATERIAL.
 - STEEP SLOPES: IN ACCORDANCE WITH NOTE NO. 14 BELOW.
- WINTER STABILIZATION** - IF WEATHER OR OTHER CONDITIONS AFTER OCTOBER 15 CAUSE INTERRUPTION OF CONSTRUCTION OR RESTORATION ACTIVITY AND PREVENT THE ESTABLISHMENT OF TEMPORARY COVER/STABILIZATION PER NOTE NO. 11 ABOVE, ONE OF THE FOLLOWING MEASURES SHALL BE IMPLEMENTED UNTIL TEMPORARY VEGETATIVE OR FINAL RESTORATION MEASURES CAN BE COMPLETED:
 - SEED WITH 1.67 BUSHELS PER ACRE (100 LBS./ACRE) OF CERTIFIED 'AROSTOOK' WINTER RYE (CEREAL RYE). MULCH THE ROW AT 3.0 TONS PER ACRE WITH WHEAT STRAW.
 - APPLICATION OF HYDROMULCH/SOIL STABILIZERS - SHALL BE CLASS IV, TYPE A - BONDED FIBER MATRIX (BFM) OR TYPE C - FLEXIBLE GROWTH MEDIUM (FGM) AS SPECIFIED IN SECTION 713-07 OF THE NEW YORK STATE DEPARTMENT OF TRANSPORTATION (NYSDOT) STANDARD SPECIFICATIONS.
- PERMANENT SOIL STABILIZATION** - IN AREAS WHERE SOIL DISTURBANCE ACTIVITY HAS PERMANENTLY CEASED AND IS NOT SUBJECT TO FURTHER DISTURBANCE OR CONSTRUCTION TRAFFIC, THE APPLICATION OF SOIL STABILIZATION MEASURES MUST BE INITIATED BY THE END OF THE NEXT BUSINESS DAY AND COMPLETED WITHIN SEVEN (7) DAYS FROM THE DATE OF FINAL ACCEPTANCE (INCLUDING SPREADING OF STOCKPILED TOPSOIL). FINAL STABILIZATION MEASURES SHALL BE APPLIED AS FOLLOWS:
 - COMPOST AND ADD SOIL PH MODIFIERS: COMPOST AND PH MODIFIERS WILL BE APPLIED IN ACCORDANCE WITH THE SOIL RESTORATION SPECIFICATIONS IN THE BLUE BOOK OR AS INDICATED ON THE DRAWINGS, AND IN ACCORDANCE WITH SECTION 2.5 OF THE SWPPP.
 - SEED MIXTURE AND MULCH: PERMANENT STEEP SLOPES SEED MIX AS SPECIFIED ON THE PROJECT LANDSCAPE/PLANTING PLAN (BY OTHERS). TO BE PLANTED BETWEEN MARCH 15 AND MAY 15, OR BETWEEN AUGUST 15 AND OCTOBER 15 (PREFERRED). MULCH SHALL BE SMALL GRAIN STRAW AT A RATE OF 90-100 LBS./1000 S.F. OR 2 TONS/ACRE, TO BE APPLIED AND ANCHORED ACCORDING TO THE LOCAL STANDARDS AND SPECIFICATIONS IN THE BLUE BOOK.
 - TREES, SHRUBS, AND PLANTS WITH MULCH: TO BE PLANTED AS SPECIFIED AND DETAILED ON THE PROJECT LANDSCAPE/PLANTING PLAN (BY OTHERS). MULCH SHALL BE SHREDDED CEDAR BARK AS APPROVED BY THE LANDSCAPE ARCHITECT, SPREAD AT A THICKNESS OF 2 OR 3 INCHES WHERE SPECIFIED ON THE PROJECT LANDSCAPE/PLANTING PLAN.
 - UNTIL PERMANENT STABILIZATION IS ACHIEVED (I.E. MINIMUM 80% DENSITY OF VEGETATIVE AND/OR HARDSCAPE COVER), CONSTRUCTION WORK AREAS WILL BE SUBJECT TO A CONTINUED INSPECTION AND MAINTENANCE PROGRAM AS SPECIFIED IN THE DRAWINGS AND/OR SWPPP. FOR AREAS WHERE ESTABLISHMENT OF VEGETATION IS UNSUCCESSFUL IN THE FIRST GROWING SEASON AFTER SEEDING, PH AND ORGANIC MATTER LEVELS SHALL BE CHECKED USING LAB ANALYSIS TO DETERMINE IF ADDITIONAL MODIFIERS ARE NEEDED PRIOR TO RESEEDING.
- CUT OR FILL SLOPES STEEPER THAN 3 HORIZONTAL TO 1 VERTICAL (3H:1V), AND AREAS OF SOILS WITH SEVERE EROSION POTENTIAL WHERE INDICATED ON THE PLANS SHALL BE STABILIZED IMMEDIATELY AFTER GRADING AND AFTER COMPLETION OF DAILY CONSTRUCTION ACTIVITIES AS DIRECTED BY THE ENVIRONMENTAL/E&S INSPECTOR(S), WITH A TEMPORARY COVER OF STRAW MULCH OR EQUIVALENT AT A RATE OF 3 TONS/ACRE (SEE THE LOCAL STANDARDS AND SPECIFICATIONS IN THE BLUE BOOK) OR WITH EROSION CONTROL MATTING (BLANKETS).
- PAVED ROADWAYS SHALL BE KEPT CLEAN AT ALL TIMES USING MANUAL AND/OR MECHANICAL SWEEPING MEASURES.
- CATCH BASINS/DRAIN INLETS AS SHOWN ON THE PLANS, OR AT OTHER LOCATIONS AS DIRECTED BY THE ENVIRONMENTAL/E&S INSPECTOR, MUST BE PROTECTED ACCORDING TO THE METHODS SHOWN ON THE E&S DETAIL SHEETS OR IN THE BLUE BOOK PRIOR TO THE START OF CONSTRUCTION. STORM DRAINAGE OUTLETS SHALL BE STABILIZED, AS REQUIRED, BEFORE THE DISCHARGE POINTS BECOME OPERATIONAL.
- CONSTRUCTION FENCING SHALL BE USED TO PROTECT EXISTING TREES TO REMAIN, AND OTHER SENSITIVE AREAS (WITH SILT FENCE WHERE APPLICABLE) WHERE SPECIFIED THAT ARE NOT TO BE DISTURBED.
- STORM WATER RUNOFF FROM DISTURBED AREAS AND DISCHARGES FROM ALL DEWATERING AND HYDROSTATIC TESTING OPERATIONS MUST PASS THROUGH A SEDIMENT FILTER DEVICE OR PRACTICE AS DETAILED ON THE DRAWINGS OR AS APPROVED BY THE ENGINEER, ENVIRONMENTAL/E&S INSPECTOR, AND/OR NYCDPE BEFORE BEING DISCHARGED BEYOND DISTURBED AREAS, OR DRAINAGE INTO INLETS, WATERWAYS, OR OTHER DRAINAGE SYSTEMS. THE FILTERING DEVICE/PRACTICE SHALL BE LOCATED WHERE SHOWN ON THE PLANS; IN FLAT, UPLAND AREAS WHERE VEGETATION IS PRESENT (IF POSSIBLE).
- DUST CONTROL** - WATER SHALL BE APPLIED BY SPRINKLER OR WATER TRUCK DURING EARTHWORK AND GRADING OPERATIONS TO MINIMIZE SEDIMENT TRANSPORT AND MAINTAIN ACCEPTABLE AIR QUALITY CONDITIONS. REPEATED TREATMENTS SHALL BE DONE AS NEEDED UNTIL GRADES ARE STABILIZED.

TABLE 4.6		
TYPE OF SOIL DISTURBANCE	SOIL RESTORATION REQUIREMENTS	COMMENTS/EXAMPLES
NO SOIL DISTURBANCE	RESTORATION NOT PERMITTED	PRESERVATION OF NATURAL FEATURES
MINIMAL SOIL DISTURBANCE	RESTORATION NOT REQUIRED	CLEARING AND GRUBBING
AREAS WHERE TOPSOIL IS STRIPPED ONLY - NO CHANGE IN GRADE	HSG A&B APPLY 6 INCHES OF TOPSOIL	HSG C&D APPLY 6 INCHES OF TOPSOIL
AREAS OF CUT OR FILL	HSG A&B AREATE* AND APPLY 6 INCHES OF TOPSOIL	HSG C&D APPLY FULL SOIL RESTORATION**
HEAVY TRAFFIC AREAS ON SITE (ESPECIALLY IN A ZONE 5-25 FEET AROUND BUILDINGS BUT NOT WITHIN A 5 FOOT PERIMETER AROUND FOUNDATION WALLS)	APPLY FULL SOIL RESTORATION (DECOMPACTION AND COMPOST ENHANCEMENT)	
AREAS WHERE RUNOFF REDUCTION AND/OR INFILTRATION PRACTICES ARE APPLIED	RESTORATION NOT REQUIRED BUT MAY BE APPLIED TO ENHANCE THE REDUCTION SPECIFIED FOR APPROPRIATE PRACTICES.	KEEP CONSTRUCTION EQUIPMENT FROM CROSSING THESE AREAS, TO PROTECT NEWLY INSTALLED PRACTICE FROM ANY ONGOING CONSTRUCTION ACTIVITIES CONSTRUCT A SINGLE-PHASE OPERATION FENCE AREA
REDEVELOPMENT PROJECTS	SOIL RESTORATION IS REQUIRED ON REDEVELOPMENT PROJECTS IN AREAS WHERE EXISTING IMPERVIOUS AREA WILL BE CONVERTED TO PERVIOUS AREA.	

* AERATION INCLUDES THE USE OF MACHINES SUCH AS TRACTOR-DRAWN IMPLEMENTS WITH COULTERS MAKING A NARROW SLIT IN THE SOIL, A ROLLER WITH MANY SPIKES MAKING INDENTATIONS IN THE SOIL, OR PRONGS WHICH FUNCTION LIKE A MINI-SUBSOILER
 ** PER "DEEP RIPPING AND DECOMPACTION, DEC 2008"
 HSG - HYDROLOGIC SOIL GROUP
 SOURCE: NEW YORK STATE STANDARDS AND SPECIFICATIONS FOR EROSION AND SEDIMENT CONTROL NOVEMBER 2016

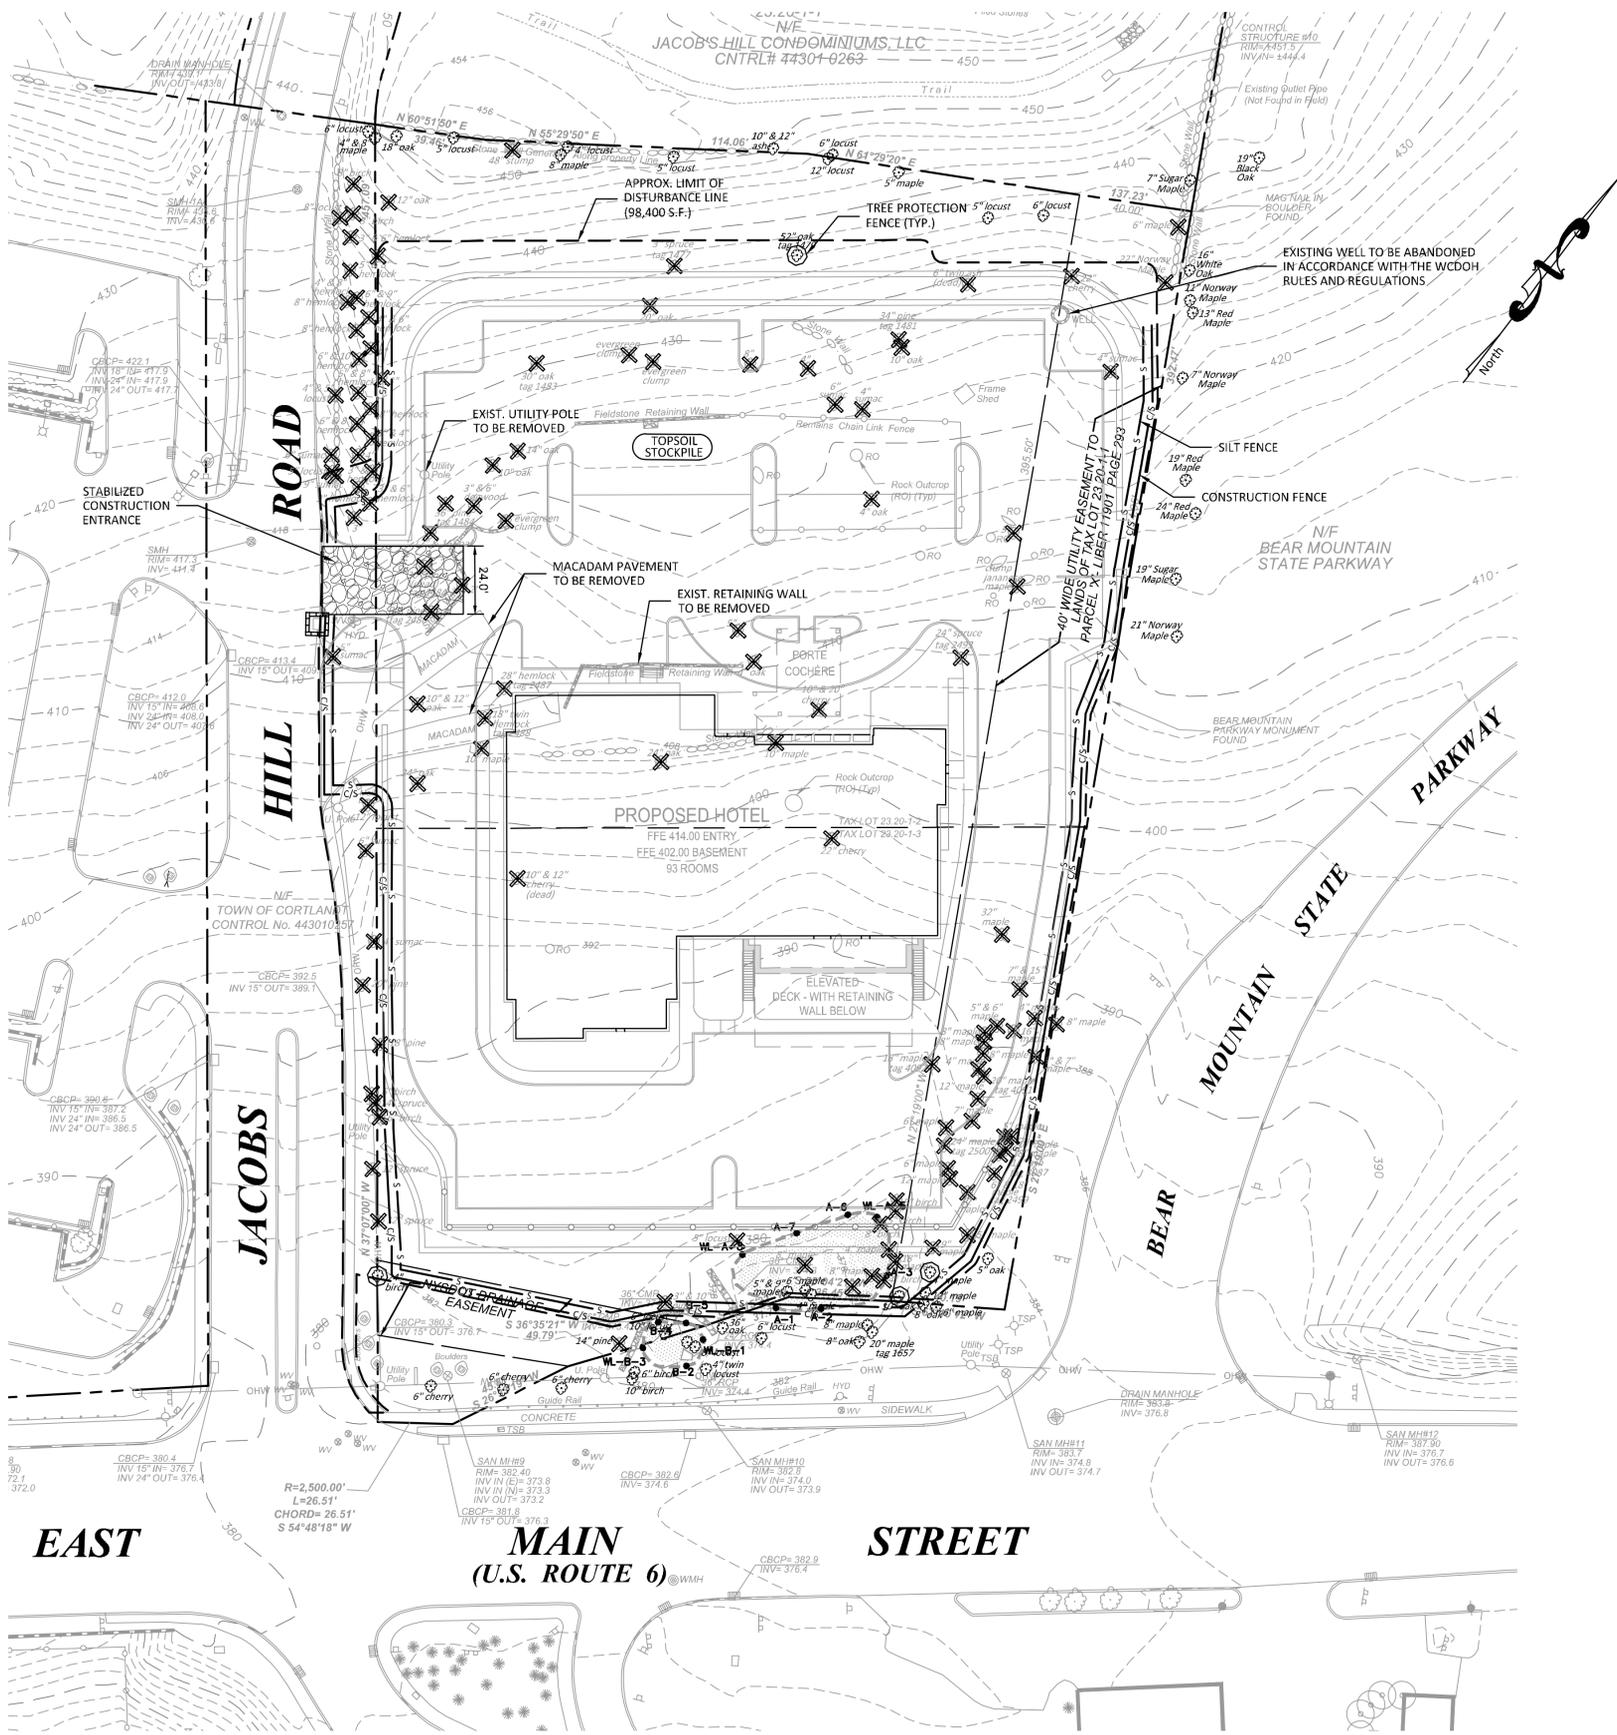

NO.	REVISION	DATE
1	ISSUED TO PLANNING BOARD	7/19/2023

EROSION CONTROL LEGEND

- STABILIZED CONSTRUCTION ENTRANCE
- INLET SEDIMENT BAG
- SILT FENCE/SEDIMENT BARRIER
- CONSTRUCTION FENCE
- TREE TO BE PROTECTED
- TREE TO BE REMOVED
- LIMITS OF DISTURBANCE

Scale: 1" = 30'

Attorney	Zarin & Steinmetz, LLP 81 Main Street, Suite 415 White Plains, NY 10601 Tel: 914-682-7800
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2054 EAST MAIN STREET
TOWN OF CORTLANDT, NY
Section 23.20, Block: 1, Lots: 2 & 3

TITLE:
EROSION CONTROL PLAN

Scale: 1" = 30'

Date: 04/26/2023

Drawn By: KMM

Checked By: PIG

Project No.: 1021

Sheet No.: 8 of 12

Dwg. No.: C-501

Seal: STATE OF NEW YORK
PETER J. GREGORY
LICENSED PROFESSIONAL ENGINEER
No. 071226

G:\PROJECTS\DTS\1021 - Cortlandt Manor\AutoCAD\SPAC-SOI Erosion Control Plan.dwg



Client:
 BILAL AHMAD
 116 COURTYARD DRIVE
 ONEONTA NY 13820

PB SUBMISSION
 NOT FOR CONSTRUCTION

CORTLANDT MANOR
 2054 EAST MAIN STREET
 CORTLANDT, NEW YORK 10567

REVISIONS

PB SUBMISSION II - 11/21/22
 TREE PROTECT PLAN - 11/28/22
 UPDATED SITE PLAN - 1/9/23
 ZBA PLAN - 1/18/23
 ZBA PUBLIC HEARING - 2/16/23
 ZBA RESUBMISSION - 2/21/23
 PB PRESENTATION - 3/4/23
 PB SUBMISSION - 4/26/23
 ISSUED TO PB - 7/19/23

Drawn By: C.R.F.
 Checked By: E.G.K.
 KFA Proj. No.: 41108
 Date: OCTOBER 19, 2022
 Scale: AS NOTED

Title:
LANDSCAPE PLAN

C-701

PLANT LIST

KEY	COMMON NAME	BOTANICAL NAME	CALIPER	HEIGHT	CONDITION
TREES					
Ag	AUTUMN BRILLIANCE SERVICEBERRY	AMELANCHIER GRANDIFOLIUM 'AUTUMN BRILLIANCE'	2-1/2" CAL	-	B4B
Ar	AUTUMN BLAZE RED MAPLE	ACER X FREEMAN 'AUTUMN BLAZE'	2 1/2" CAL.	-	B4B
Cr	STELLAR PINK DOGWOOD	CORNUS X RUTGERENSIS 'STELLAR PINK'	-	6-8'	B4B
Cc	EASTERN REDBUD	CERCIS CANADENSIS	-	6-8'	B4B
Gb	PRINCETON SENTRY GINKGO	GINKGO BILOBA 'PRINCETON SENTRY'	1-1/2" CAL.	-	B4B SINGLE STEM
Lt	TULIPTREE	LIRIODENDRON TULIPIFERA	2-1/2" CAL.	-	B4B
Pa	LONDON PLANETREE	PLATANUS X ACERIFOLIA	2-1/2" CAL.	-	B4B
Pb	BRUNS SERBIAN SPRUCE	PICEA OMORIKA 'BRUNS'	-	8-10'	B4B
Pf	VANDERWOLF'S PYRAMID LIMBER PINE	PINUS FLEXILIS 'VANDERWOLF'S PYRAMID'	-	6-8'	B4B
Qm	CHINKAPIN OAK	QUERCUS MUEHLENBERGII	2-1/2" CAL.	-	B4B
Ts	GREEN GIANT ARBORVITAE	THUJA STANDISHII X PLICATA	-	6-8'	B4B
SHRUBS					
Ca	PINK SUMMERSWEET	CLETHRA ALNIFOLIA ROSEA	-	-	3 GAL.
Cf	YELLOW TWIG DOGWOOD	CORNUS SERICEA FLAVIRAMEA'	-	-	3 GAL.
Cs	RED TWIG DOGWOOD	CORNUS ALBA 'SIBIRICA'	-	-	3 GAL.
Iv	LITTLE HENRY DWARF VIRGINIA SWEETSPIRE	ITEA VIRGINICA 'SPRICH'	-	-	3 GAL.
Js	BROADMOOR JUNIPER	JUNIFERUS SABINA 'BROADMOOR'	-	-	3 GAL.
Hm	ENDLESS SUMMER HYDRANGEA	HYDRANGEA MACROPHYLLA 'ENDLESS SUMMER'	-	24"-36"	-
Hp	PEPPER MINT SWIRL HYDRANGEA	HYDRANGEA MACROPHYLLA 'PEPPERMINT SWIRL'	-	24"-36"	-
Ph	TINY WINE NINEBARK	PHYSCOCARPUS OPULIFOLIUS 'TINY WINE'	-	-	3 GAL.
Ss	GOLD FLAME SPIREA	SPIREA BUMALDA 'GOLD FLAME'	-	18"-24"	-
Spl	GOLDMOUND SPIREA	SPIREA JAPONICA 'GOLDMOUND'	-	-	3 GAL.
To	LITTLE GIANT DWARF ARBORVITAE	THUJA OCCIDENTALIS 'LITTLE GIANT'	-	18"-24"	-
PERENNIALS and GRASSES					
G-Hm	HAKONE GRASS	HAKONECHLOA MACRA	-	-	2 GAL.
G-Pa	LITTLE BUNNY FOUNTAIN GRASS	PENNISETUM ALOPECUROIDES 'LITTLE BUNNY'	-	-	2 GAL.
P-E	KIM'S KNEE HIGH CONEFLOWER	ECHINACEA PURPUREA 'KIM'S KNEE HIGH'	-	18"-24"	-
P-Ep	DWARF WHITE CONEFLOWER	ECHINACEA PURPUREA 'WHITE SWAN'	-	-	1 GAL.
P-H	HOSTA 'BLUE MOUSE EARS'	HOSTA X 'BLUE MOUSE EARS'	-	-	1 GAL.
P-Hg	GOLD DROP HOSTA	HOSTA GOLD DROP	-	-	1 GAL.
P-L	LILYTURF	LIRIOPE MUSCARI 'BIG BLUE'	-	-	PLUG
P-N	CATMINT	NEPATA RACEMOSA 'CATS PAJAMAS'	-	-	2 GAL.

PLANT NOTES

- ▲ 3" DEPTH SHREDDED BARK MULCH WITH 18" OF SCREENED TOPSOIL.
- ▲ INSTALL LANDSCAPE EDGING AS SPECIFIED.
- ▲ SEE TREE PROTECTION PLAN FOR EXTENT OF TREE REMOVALS.
- ▲ SHOULD LABELS AND SYMBOLS HAVE A DISCREPANCY, SYMBOLS PREVAIL IN NUMBER OF PLANTS.
- ▲ ONLY EXISTING TREES TO REMAIN ARE SHOWN ON THIS PLAN.

