




1 SITE PLAN- BASED ON SURVEY PERPARED BY BUNNY ASSOICATES LAND SURVEYORS

TOWN OF COF	RTLANDT ZOING	G REQUIREMEN	NTS
	SECTION: <u>13.9</u> BLC	DCK: <u>2</u> LOT: <u>23</u> ID USE: <u>ACCESSORY</u>	
BULK REGULATIONS	REQUIRED/ ALLOWABLE	EXISTING/ PROPOSED	VARIANCE REQUIRED
LOT AREA	40,000 SF	13,195.15 SF	NONE
MAX BUILDING COVERAGE: DWELLING USE: NON DWELLING USE: MAX BUILDING FLOOR AREA:	3,455 SF 3,455 SF 5,300 SF	2,782 SF 868 SF 3,650 SF EXIST. 3,650 SF PROP.	NONE NONE NONE
ACCESSORY APARTMENT: ALLOWABLE SF*** 25% OF PRIMARY STRUCTURE TO MAX OF 600 SF ***3650 X .25=695 SF FT	600 SF	495 SF	NONE
PARKING	2 PER DWELLING UNIT	4 REQUIRED 8 EXISTING	NONE

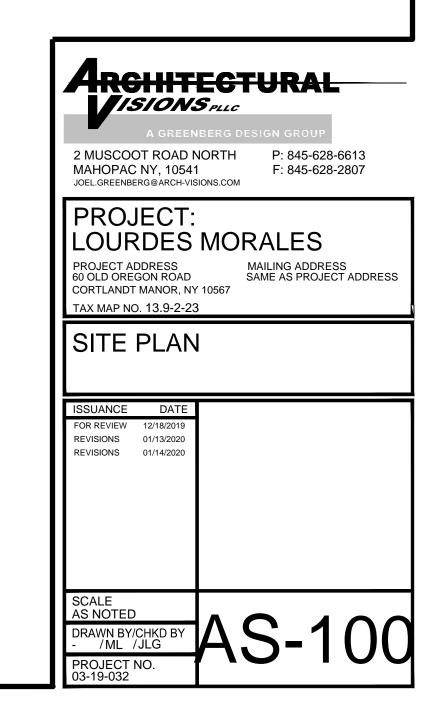

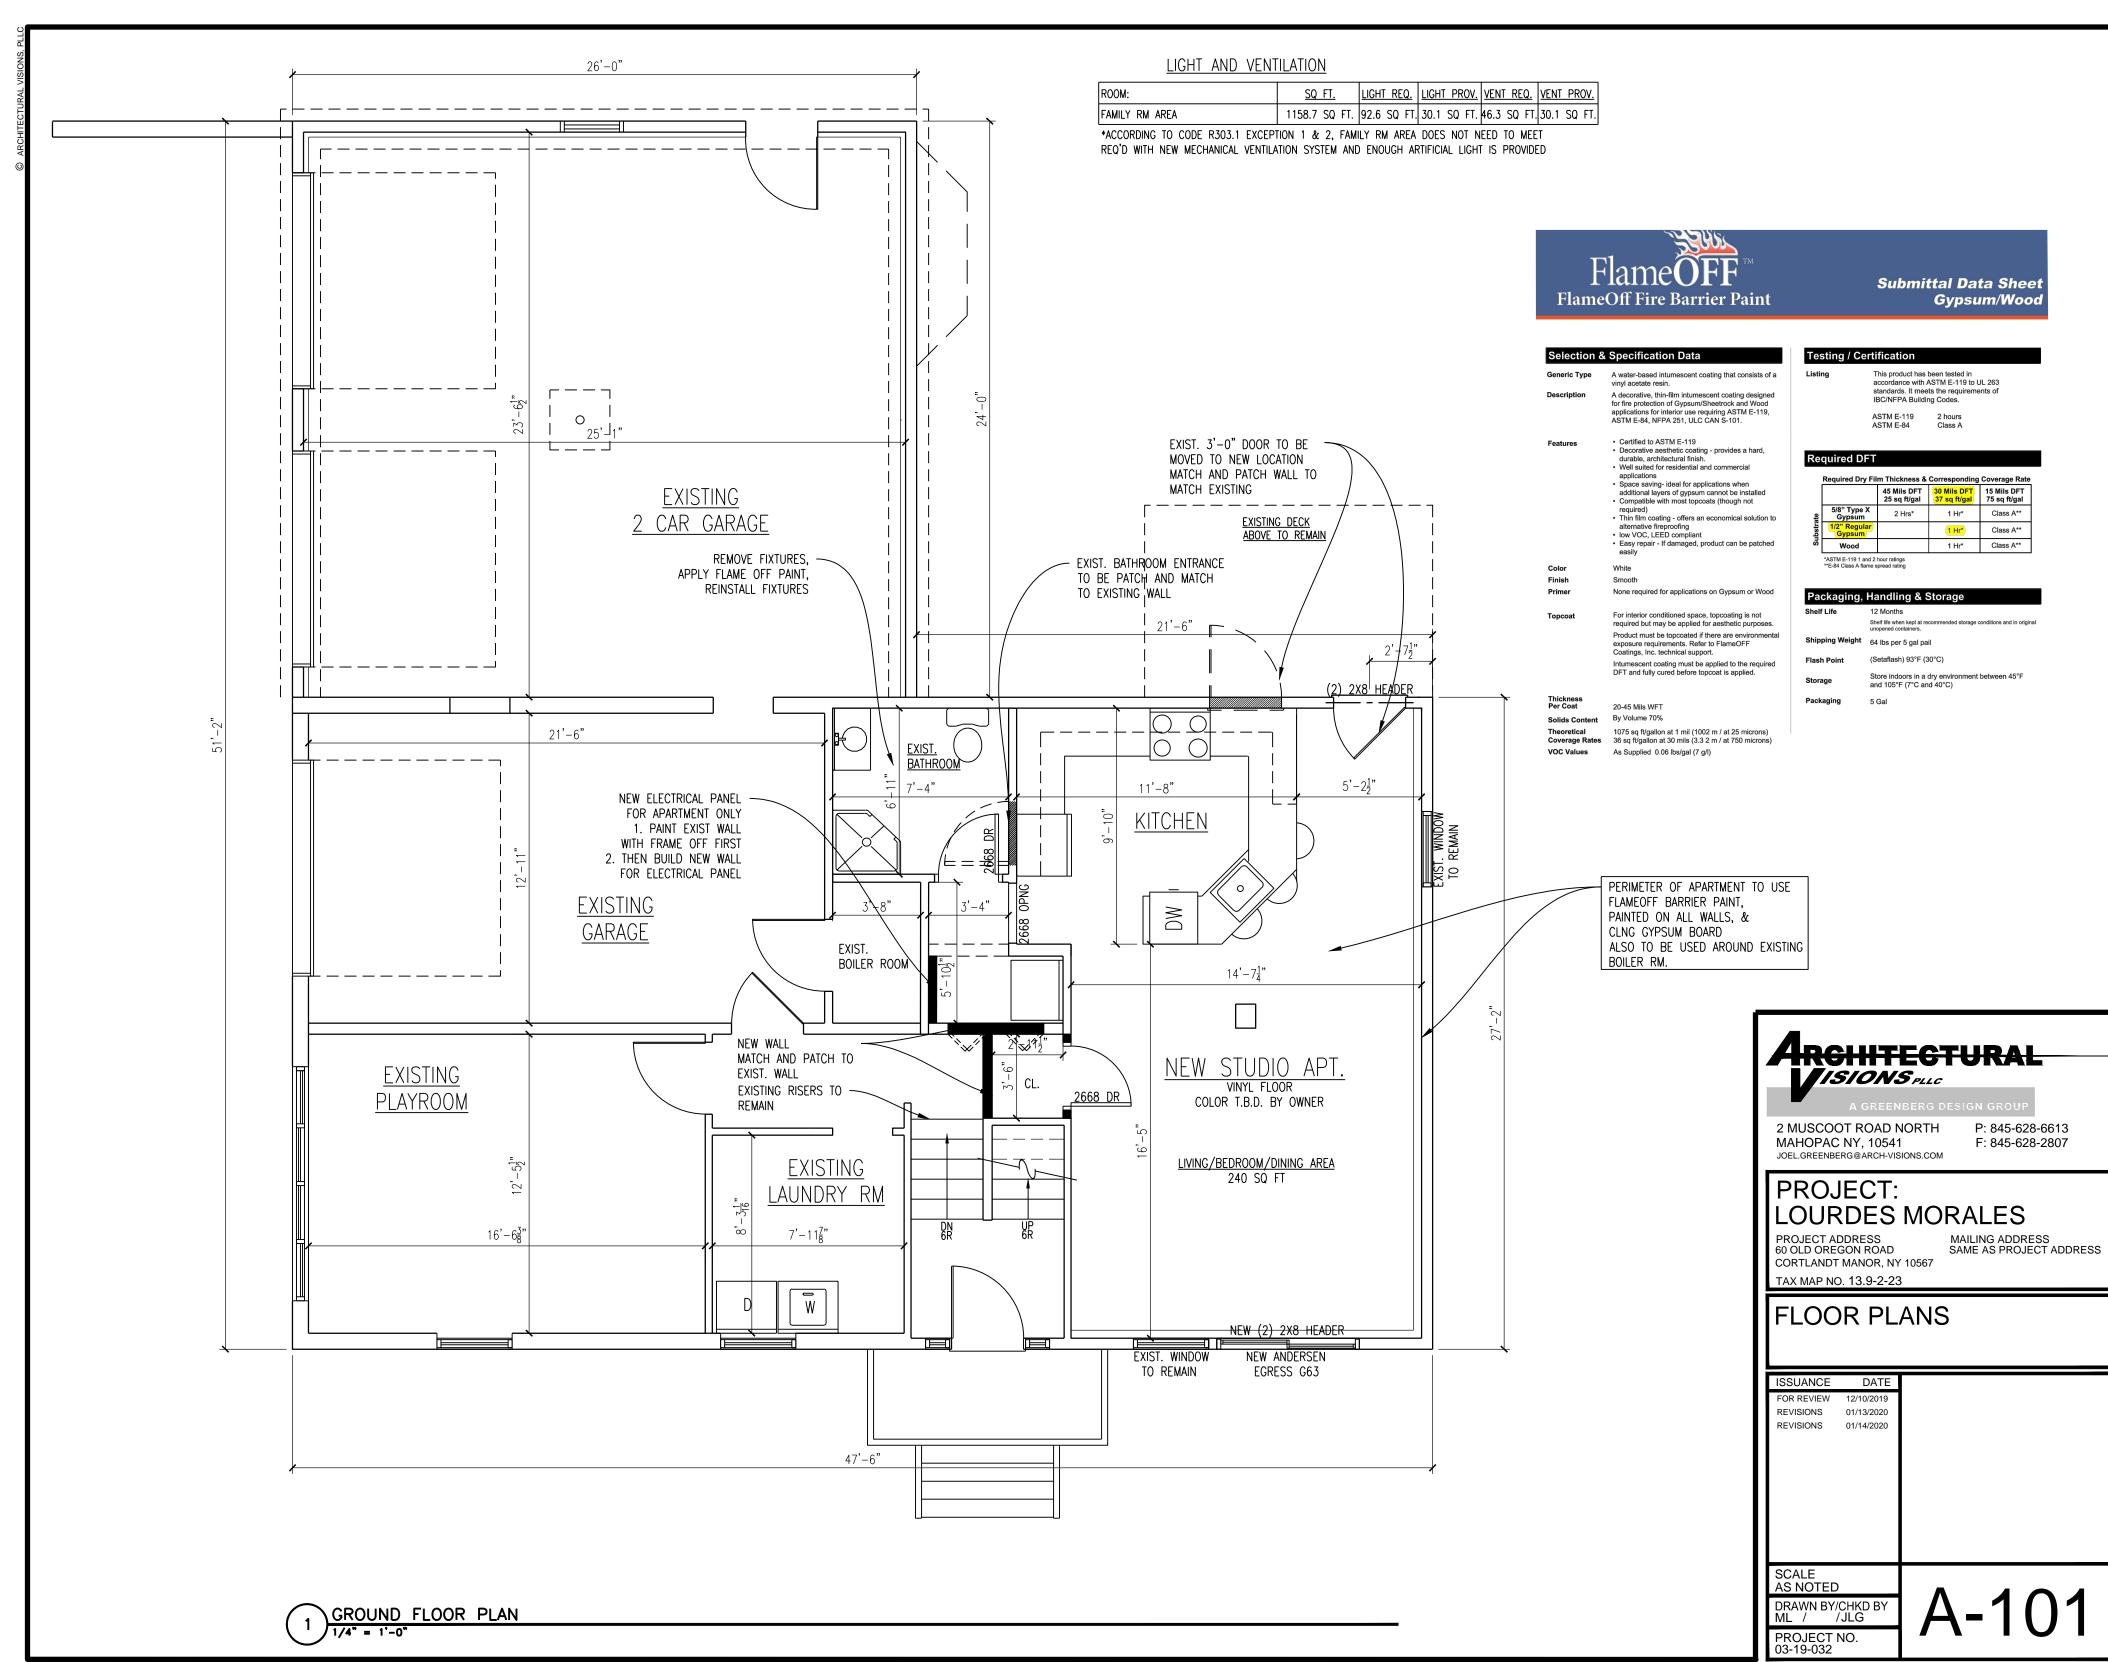

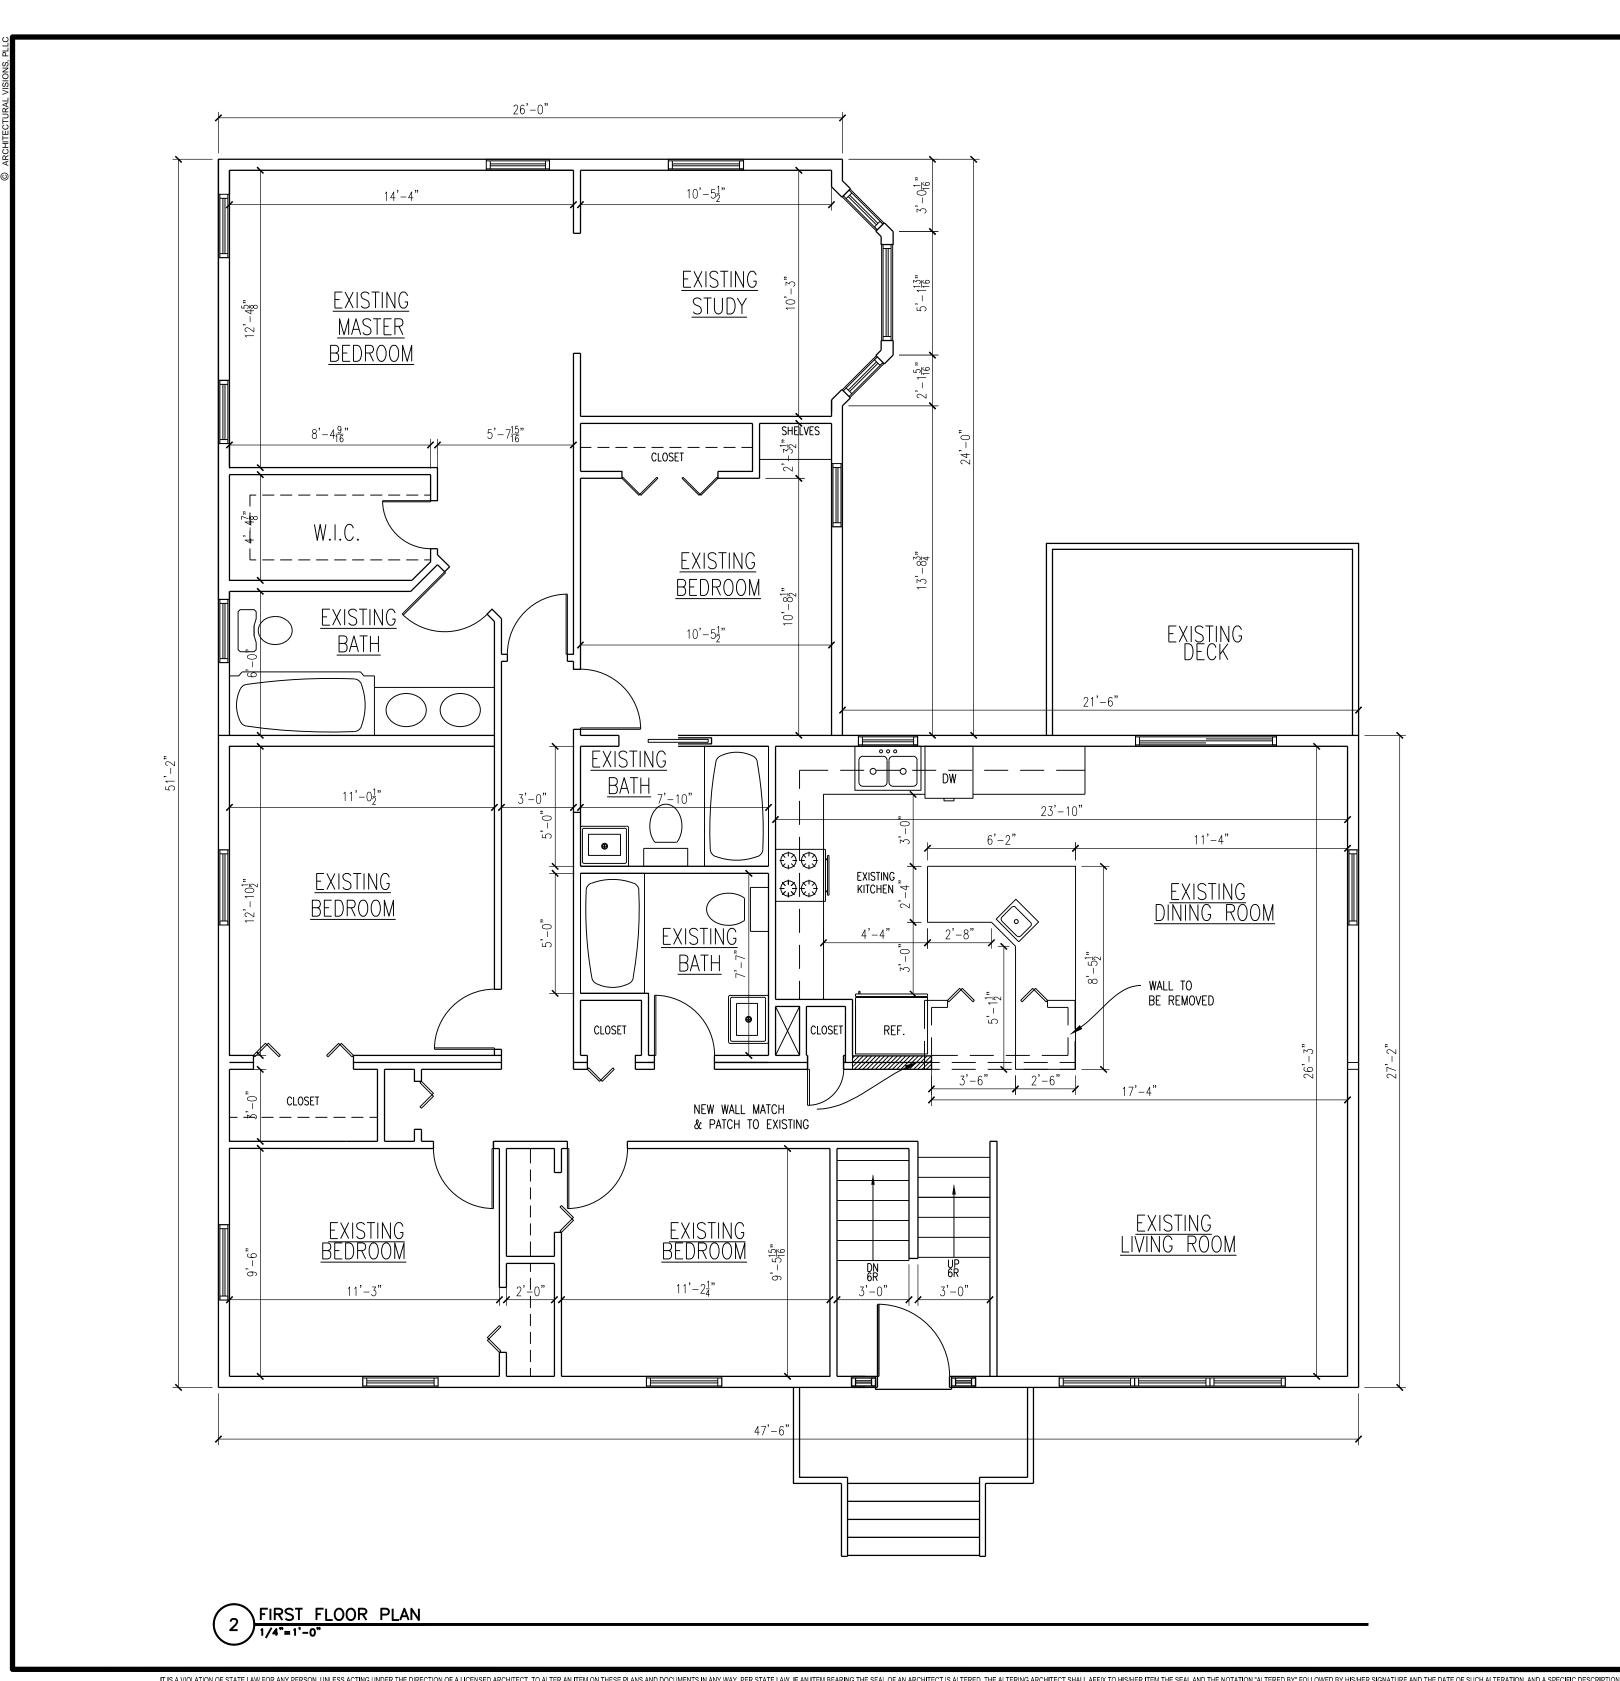

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P: 845-628-6613 F: 845-628-2807

PROJECT: LOURDES MORALES

PROJECT ADDRESS 60 OLD OREGON ROAD CORTLANDT MANOR, NY 10567 MAILING ADDRESS SAME AS MAILING ADDRESS

FIRST FLOOR PLAN


ISSUANCE DATE 12/10/2019 SUBMITTAL 12/18/2019 REVISIONS 01/13/2020

TAX MAP NO. 13.9-2-23


SCALE AS NOTED

A-102 DRAWN BY/CHKD BY ML /- /JLG PROJECT NO. 03-19-032

IT IS A VIOLATION OF STATE LAW FOR ANY PERSON, UNLESS ACTING UNDER THE DIRECTION OF A LICENSED ARCHITECT, TO ALTER AN ITEM ON THESE PLANS AND DOCUMENTS IN ANY WAY. PER STATE LAW, IF AN ITEM BEARING THE SEAL OF AN ARCHITECT IS ALTERED, THE ALTERING AND THE SEAL OF AN ARCHITECT IS ALTERED, THE ALTERING ARCHITECT SHALL AFFIX TO HIS/HER ITEM THE SEAL OF AN ARCHITECT IS ALTERED, THE ALTERING AND THE DIRECTION OF THE ALTERATION, THIS ARCHITECT DENIES ANY AND ALL RESPONSIBILITY FOR ALTERATIONS OF THESE PLANS AND DOCUMENTS. BY OTHERS AND EXPRESSLY DENIES PERMISSION TO OTHERS TO ALTER THESE PLANS AND DOCUMENTS.

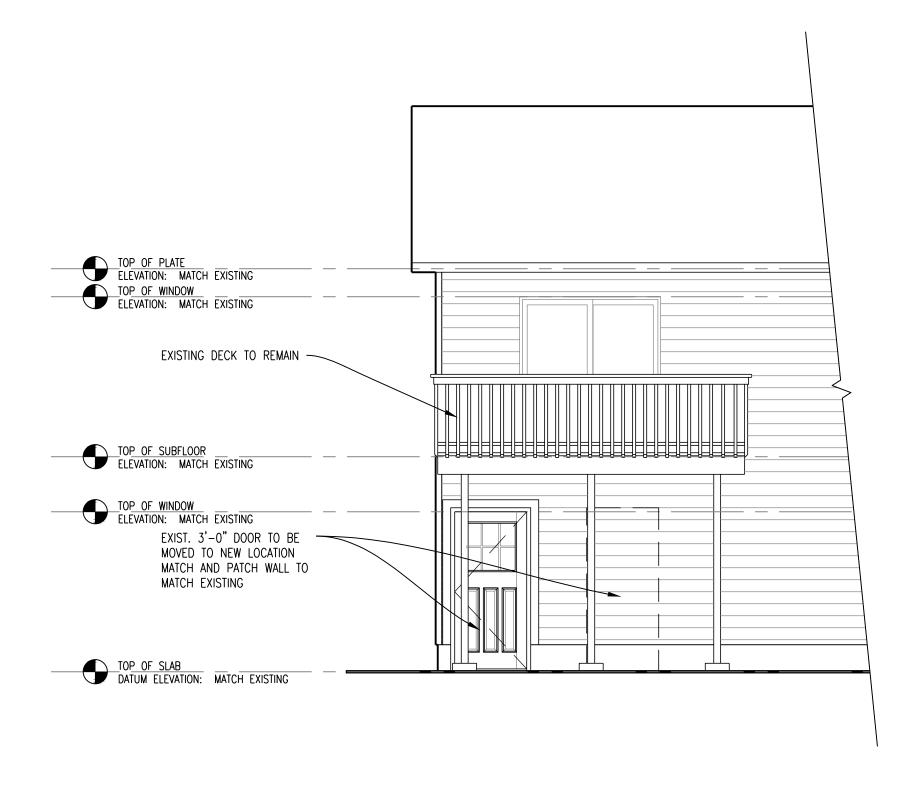

PARTIAL REAR ELEVATION

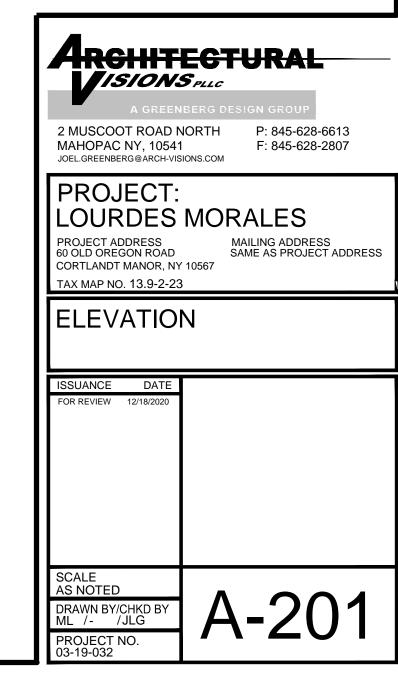

SITE DATA NOTES:

. OWNER: LOURDES MORALES 60 OLD OREGON ROAD **CORTLANDT MANOR, NY 10567**

2. ZONE:

R-10

3. PROPOSED PROJECT USE: RESIDENTIAL

4. TAX MAP NO.

SECTION 13.9 **BLOCK** 2 LOT 23

5. WATER/ SEWER: SEWER / TOWN WATER **DESIGN LOADS** FLOOR LIVE LOAD:

40 psf ATTIC LIVE LOAD: 20 psf

SNOW LOADING **GROUND SNOW LOAD:**

WIND LOADING **BASIC WIND SPEED:**

STRUCTURAL DESIGN LOADS

110 mph

30 psf

WIND EXPOSURE CATEGORY: C

					CLIMATE	TABLE AND GEOGRA	R301.1(1) APHIC DESI	GN CRITERI	<u>A</u>			
GROUND SNOW		WIND DESI	GN		SEISMIC	SUBJECT	TO DAMAG	E FROM	WINTER	ICE BARRIER	FLOOD	AIR FREEZING
LOAD	Speed (mph)	Topographic effects	Special wind region	Wind-borne debris zone	DESIGN CATEGORY	Weathering	Frost line depth	Termite	DESIGN TEMP	UNDERLAYMENT REQUIRED	HAZARDS	INDEX
30	*SPECIAL WIND REGION	NO	YES	NO	С	SEVERE	42"	MOD. TO HEAVY	7	YES	N	1500 OR LESS

<u>GENERAL NOTES:</u> DO NOT SCALE OR MEASURE

ANY DRAWING. VERIFY THE FIGURES, DIMENSIONS, AND DESIGN INTENT SHOWN ON THE DRAWINGS BEFORE BEGINNING LAYOUT OF THE WORK AND REPORT ANY ERRORS. INACCURACIES. MISSING DIMENSIONAL REQUIREMENTS, OR CONFLICTS TO THE ARCHITECT BEFORE BEGINNING ANY WORK. VERIFY THE PARTITION LAYOUT IN THE FIELD WITH THE ARCHITECT BEFORE BEGINNING NEW PARTITION WORK.

NOTIFY THE ARCHITECT IN WRITING OF ALL ERRORS AND DISCREPANCIES BEFORE PROCEEDING WITH THE WORK.

- ALL WORK SHALL COMPLY WITH ALL APPLICABLE CODES, LAWS, AND STATUTES AS REQUIRED. STRICTLY ADHERE TO MANUFACTURER'S PRINTED INSTRUCTIONS.
- ALL DIMENSIONS TAKEN TO EXTERIOR OF FRAMING (FACE OF EXISTING WALL SHEATHING AT EXISTING EXTERIOR WALLS) OR FACE OF MASONRY UNLESS SPECIFICALLY NOTED OTHERWISE.
- VERIFY EXACT LAYOUT COMPATIBILITY WITH REQUIRED SETBACKS <u>BEFORE</u> BEGINNING WORK.
- VERIFY EXACT LAYOUT COMPATIBILITY WITH ALL EXISTING CONDITIONS BEFORE 6. BEGINNING WORK. IF ANY DISCREPANCIES ARE FOUND, NOTIFY ARCHITECT IN WRITING BEFORE BEGINNING WORK.
- IN FINISHED SPACES, CONCEAL PIPES, DUCTS, AND WIRING WITHIN THE CONSTRUCTION.
- DO NOT CUT OR ALTER STRUCTURAL OR BUILDING ENCLOSURE ELEMENTS WITHOUT THE ARCHITECT'S PRIOR WRITTEN APPROVAL.

EXISTING CONDITIONS:

- DRAWINGS SHOWING EXISTING CONSTRUCTION AND UTILITIES ARE BASED ON CASUAL FIELD OBSERVATION AND EXISTING RECORD DOCUMENTS ONLY.
- VERIFY THAT CONSTRUCTION AND UTILITY ARRANGEMENTS ARE AS SHOWN.

- REPORT DISCREPANCIES TO 1.2. ARCHITECT BEFORE DISTURBING EXISTING INSTALLATION.
 - BEGINNING OF ALTERATIONS WORK CONSTITUTES ACCEPTANCE OF EXISTING CONDITIONS.

ROUGH CARPENTRY: 1. ALL STRUCTURAL WOOD SHALL CONFORM TO AF&PA "NATIONAL DESIGN SPECIFICATION-CURRENT EDITION" DESIGN VALUES FOR STRESS-GRADE LUMBER AND

ITS FASTENINGS. 2. A.P.A. RATED SHEATHING

- 2.1. $\frac{3}{4}$ " T&G PLYWOOD SUBFLOOR GLUED WITH PL400 ADHESIVE AND SCREWED AT 12" O.C. INTERMEDIATE AND 6" O.C. AT PERIMETER.
- STUDS, JOISTS, RAFTERS, AND OTHER STRUCTURAL LUMBER SHALL BE NO. 2 OR BETTER DOUGLAS FIR-LARCH WITH BASE STRESS RATING OF AT LEAST 825 PSI, DRY, WITH MOISTURE CONTENT OF 19% MAXIMUM.
- 4. NON-STRUCTURAL LUMBER SHALL BE STANDARD GRADE DOUGLAS FIR-LARCH, DRY. WITH MOISTURE CONTENT OF 19% MAXIMUM (OR SAME AS STRUCTURAL LUMBER) FRAME ALL EXTERIOR WALLS
- WITH 2X6 STUDS @ 16" O.C. FRAME INTERIOR WALLS WITH 2X4 STUDS @ 16" O.C. UNLESS NOTED OTHERWISE. CONNECTING STEEL PLATES, SHOES, BOLTS, AND OTHER MATERIAL SHALL BE A36 STEEL. WELDS TO BE MADE
- USING E70XX ELECTRODES. MISCELLANEOUS CONNECTORS 2. INTERIOR TRIM: CLEAR SHALL BE BY SIMPSON STRONG-TIE CO., INC. OR EQUAL, FULL DEPTH AND FULLY NAILED AS PER MANUFACTURER'S INSTRUCTIONS.
- 8. PROVIDE CROSS BRIDGING OR SOLID BLOCKING BETWEEN ALL JOISTS AT THE
- FOLLOWING FREQUENCY: 8.1. 0' - 8' REQUIRED
- 8.2. 8' - 16' ONE
- ROW AT MIDSPAN PROVIDE SOLID BLOCKING 6. SOFTWOOD PLYWOOD: UNDER HEAVY FIXTURES, EQUIPMENT, OR APPLIANCES (BATHTUBS,

NOT

- KITCHEN ISLANDS, ETC.). 9. DOUBLE FRAMING MEMBERS UNDER ALL PARALLEL **PARTITIONS**
- 10. DOUBLE FRAMING MEMBERS AT OPENINGS GREATER THAN 16"X16"
- 11. FULLY SPIKE ALL POSTS AND **JAMBS**
- 12. PROVIDE 2X4 BLOCKING UNDER ALL POSTS AND UNDER JAMBS OF WINDOW/DOOR OPENINGS EXCEEDING 6'-0" IN WIDTH.
- 13. ALL LAMINATED VENEER LUMBER AND COMPOSITE LUMBER SHALL BE TRUS JOIST BY ILEVEL OR APPROVED EQUAL. THE CONTRACTOR IS REQUIRED TO STUDY THE ILEVEL PUBLICATION #TJ-9000 "SPECIFIER'S GUIDE -BEAMS, HEADERS, AND COLUMNS FEATURING TRUS JOIST TIMBERSTRAND LSL, MICROLLAM LVL, AND PARALLAM PSL.
- 14. SUBMIT FOR REVIEW THE EXACT CONNECTION MANUFACTURER'S DATA SHEETS FOR EACH TYPE OF CONNECTION SPECIFIED.ALL NAILED CONNECTIONS SHALL BE SECURED IN ACCORDANCE WITH NAILING SCHEDULE FROM THE 2015 IRC W/NYS CODE SUPPLEMENT.

FINISH CARPENTRY:

- 1. PERFORM AND INSTALL WORK IN ACCORDANCE WITH CUSTOM GRADE AWI (ARCHITECTURAL WOODWORK INSTITUTE) QUALITY STANDARDS.
- POPLAR OR PRIMED PINE (AS SELECTED BY OWNER), PLAIN SAWN WITH A MAXIMUM MOISTURE CONTENT OF 13%.
- 3. HARDWOOD LUMBER 3.1. SELECT RED OAK, PLAIN SAWN WITH A MAXIMUM MOISTURE CONTENT OF 13% OF QUALITY CAPABLE OF TRANSPARENT FINISH. **COUNTERTOPS:**
- SOLID SURFACE AS SELECTED BY OWNER, I.E. QUARTZ, GRANITE, ETC... APA - EXT MDO PLYWOOD EXTERIOR GLUE

7. HARDWOOD PLYWOOD:

CUSTOM GRADE IN ACCORDANCE WITH AWI: CORE MATERIAL OF MEDIUM DENSITY PARTICLE BOARD; FACE VENEER ROTARY BIRCH.

SYMBOLS

2

INSULATION:

- PROVIDE CONTINUOUS THERMAL INSULATION AND CONTINUOUS TYVEK HOUSEWRAP AIR BARRIER AT BUILDING ENCLOSURE WHETHER SPECIFICALLY SHOWN ON DRAWINGS OR NOT. SHINGLE AIR BARRIER FOR PROPER DRAINAGE. SEAL JOINTS WITH TYVEK TAPE. FLASH OPENINGS AND PENETRATIONS WITH TYVEK FLEXWRAP SELF-ADHERED BUTYL FLASHING. INSTALL IN STRICT ACCORDANCE WITH MANUFACTURER'S INSTRUCTIONS. BATT INSULATION: ASTM
- C665; PRE-FORMED, HIGH DENSITY GLASS FIBER BATT OR ROLL, FRICTION FIT; PROVIDE KRAFT FACED BATT INSULATION AT EXTERIOR WALLS. <u>DO NOT</u> COMPRESS INSULATION. DO NOT SIDE STAPLE FACING. LAP KRAFT FACING AND FRONT STAPLE TO EDGE OF STUDS.
- SOUND ATTENUATION BLANKETS: UNFACED NOISE BARRIER FIBERGLASS INSULATION BLANKETS ON INTERIOR WALLS AND CEILING/FLOORS AS SHOWN ON DRAWINGS.
- 4. ACCESSORIES: TYVEK FLEXWRAP OR STRAIGHTFLASH BUTYL RUBBER SELF ADHERED FLASHING TAPE.
- 5. INSULATION FASTENERS: AS RECOMMENDED BY MANUFACTURER.
- 6. INSULATION R-VALUES: SEE DRAWINGS

GYPSUM BOARD SYSTEMS:

1. PROVIDE 3" THICK OR 8" THICK FOR WALLS AND CEILING, WITH ENDS SQUARE CUT AND TAPERED EDGES; BY ONE OF THE FOLLOWING MANUFACTURERS: U.S. GYPSUM CO., NATIONAL GYPSUM CO., KAISER GYPSUM, CO. USE MOISTURE RESISTANT GWB IN ALL KITCHEN, AND

BATHROOM LOCATIONS. (DO NOT USE BEHIND CERAMIC TILE.)

ELEVATION LINE

COLUMN LINE OR GRID

BUILDING SECTION

WALL SECTION

REVISION NO.

- 2. USE METAL CORNER BEADS, L, OR J EDGE TRIM.
- 3. USE §" BUGLE HEAD SCREWS WHERE GWB IS BACKED BY 3" PLYWOOD. IN LOCATIONS WITH GWB APPLIED DIRECTLY TO STUDS, USE 13" TYPE W BUGLE HEAD SCREWS.

DOORS AND HARDWARE:

- 1. DOORS ARE TO BE SOLID CORE MOLDED WOOD COMPOSITE (6) SIX PANEL INTERIOR PAINT GRADE DOORS BY JELD-WEN OR APPROVED EQUAL. PANEL STYLE AS SELECTED BY OWNER.
- ALL HARDWARE TO BE BY SCHLAGE FOR HANDLES, LEVERS, LOCKS, AND LATCHES. PROVIDE STANLEY THREE KNUCKLE PLAIN BEARING BUTT HINGES, STANDARD WEIGHT. MISC. HARDWARE, INCLUDING BUT NOT LIMITED TO DOOR STOPS, CLOSERS, ETC., SHALL BE BY IVES OR APPROVED EQUAL. STYLE AND FINISH AS SELECTED BY OWNER; CONFIRM WITH OWNER PRIOR TO ORDERING

ELECTRICAL SERVICE:

- INCLUDED IN THE SCOPE OF THIS SECTION IS THE PROVISION OF POWER AND WIRING TO ALL APPLIANCES AND RESIDENTIAL EQUIPMENT WHETHER SPECIFICALLY STATED OR IMPLIED BY THE PROVISION OF ELECTRICAL EQUIPMENT ELSEWHERE IN THE CONTRACT DOCUMENTS.
- WIRING: COPPER THROUGHOUT. BX WITH SEPARATE GROUND WIRE OR ROMEX WIRE.
- SWITCH AND OUTLETS AND DIMMERS: LEVITON: DECORA
- COVERPLATE: SMOOTH IVORY OR WHITE PLASTIC AS SELECTED BY OWNER.
- BOXES AND ACCESSORIES, AS SHOWN ON DRAWINGS AND AS REQUIRED BY N.E.C.
- SMOKE AND CARBON MONOXIDE DETECTION SYSTEM MUST BE HARDWIRED WITH BATTERY BACKUP. FURNISH & INSTALL SMOKE DETECTORS, CARBON MONOXIDE DETECTORS, TRANSFORMERS, BOXES, WIRING, AND ALL REQUIRED ACCESSORIES FOR A

COMPLETE INSTALLATION. INSTALL SMOKE DETECTORS IN EACH BEDROOM, (1) ONE IN HALLWAYS DIRECTLY OUTSIDE OF BEDROOMS, AND (1) ONE IN BASEMENT.

A-101

| A |

 $\langle A \rangle$

(110)

PROVIDE CARBON MONOXIDE DETECTORS ON EACH FLOOR OF THE HOUSE. INSTALL (1) ONE IN HALLWAYS OUTSIDE OF BEDROOMS AND (1) ONE IN BASEMENT.

ORGANIZE OUTLETS, SWITCHES, AND

- LIGHTS AS SHOWN ON DRAWINGS INTO CIRCUITS CONFORMING TO N.E.C. IN GENERAL, KEEP LIGHTS AND CONVENIENCE OUTLETS ON SEPARATE CIRCUITS. PROVIDE GFCI OUTLETS IN BATHROOMS AS REQUIRED BY N.E.C. 8. FURNISH AND INSTALL POWER WIRING FOR EQUIPMENT, FANS, SKYLIGHTS, ETC. AS REQUIRED BY N.E.C. FURNISH AND INSTALL APPROPRIATE TYPE OF RECEPTACLE FOR EQUIPMENT WITH PLUGS ATTACHED. FOR ITEMS TO BE HARDWIRED, PROVIDE JUNCTION BOX ADJACENT TO EQUIPMENT: FINAL CONNECTIONS WILL BE MADE BY EQUIPMENT SUPPLIER.
- 9. FURNISH AND INSTALL ALL FIXTURES, WIRING, DEVICES, OUTLETS, SWITCHES, DIMMERS, THERMOSTATS, CONTROLS, AND COVERPLATES.
- FURNISH & INSTALL REQUIRED WIRING FOR EQUIPMENT, INCLUDING BUT NOT LIMITED TO HOT WATER HEATER, SPACE HEATERS, FANS, AND HEATING, VENTILATING AND AIR CONDITIONING EQUIPMENT. PROVIDE APPROPRIATE TYPE OF RECEPTACLE FOR EQUIPMENT WITH PLUGS ATTACHED. FOR ITEMS TO BE HARDWIRED, PROVIDE JUNCTION BOX ADJACENT TO EQUIPMENT; FINAL CONNECTIONS WILL BE MADE BY EQUIPMENT SUPPLIER.

architectural

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ISIONS PLLC

DETAIL NUMBER

PAGE NUMBER

DETAIL REFERENCE

WINDOW TAG

DOOR TAG

WALL PARTITION TYPE

P: 845-628-6613 F: 845-628-2807

SAME AS PROJECT ADDRESS

PROJECT:

LOURDES MORALES PROJECT ADDRESS MAILING ADDRESS

60 OLD OREGON ROAD CORTLANDT MANOR, NY 10567 TAX MAP NO. 13.9-2-23

DRAWN BY/CHKD BY ML /- /JLG

PROJECT NO.

GENERAL INFORMATION

ISSUANCE	DATE
SUBMITTAL	12/10/2019
REVISIONS	01/13/2020
SCALE	
SCALE	

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